# STORMWATER MANAGEMENT PLAN

#### EROSION CONTROL

BEFORE EARTHWORKS CAN COMMENCE THE EROSION & SEDIMENT MEASURES MUST BE IN PLACE

DURING THE CONSTRUCTION PERIOD, THESE CONTROL MEASURES WILL NEED TO BE INSPECTED & MAINTAINED REGULARLY, ESPECIALLY AFTER STORM EVENTS, BY THE CONTRACTOR.

ALL WORK IS TO BE CARRIED OUT TO PREVENT EROSION, CONTAMINATION & SEDIMENTATION OF THE STORAGE SITE, SURROUNDING AREAS & DRAINAGE SYSTEMS.

MINIMIZE DISTURBED AREA COVERED WITH NATURAL VEGETATION ONLY THOSE AREAS DIRECTLY REQUIRED FOR CONSTRUCTION ARE TO BE DISTURBED.

INSTALL EROSION/SEDIMENT CONTROL MEASURES PRIOR TO COMMENCEMENT OF CONSTRUCTION OR EXCAVATION OPERATIONS.

PROVIDE SILT FENCE/STRAW BAIL BARRIERS TO THE LOW SIDE OF ALL EXPOSED EARTH EXCAVATIONS. TIE SEDIMENT FENCING MATERIAL TO CYCLONE WIRE SECURITY FENCE. SEDIMENT CONTROL EABRIC SHALL BE AN APPROVED MATERIAL (EG. HUMES PROPEX STOP) STANDING 300mm ABOVE GROUND & EXTENDING m BELOW GROUND

ISOLATE EXISTING STORMWATER PITS WITH STRAW BALES OR SILT RAPS TO FILTER ALL INCOMING FLOWS.

DO NOT STOCKPILE EXCAVATED MATERIAL ON THE ROAD WAY.

DIVERT CLEAN WATER FROM UNDISTURBED AREAS AROUND THE WORKING AREAS.

CONSTRUCTION ENTRY/EXIT SHALL BE VIA THE LOCATION NOTED ON THE DRAWING. CONTRACTOR SHALL ENSURE ALL DROPPABLE SOL & SEDIMENT IS REMOVED PRIOR TO CONSTRUCTION TRAFFIC EXITING SITE. CONTRACTOR SHALL ENSURE ALL CONSTRUCTION TRAFFIC ENTERING AND LEAVING THE SITE DO SO IN A FORWARD

TREAT THE STORMWATER RUNOFF WITH SUSPENDED SOLDS SO THE DISCHARGE WATER QUALITY TO COUNCIL STORMWATER DRAINAGE SYSTEM HAS A MAXIMUM CONCENTRATION OF SUSPENDED SOLDS THAT DOES NOT EXCEED 50 MILLIGRAMS PER LITRE IN ACCORDANCE WITH THE PROTECTION OF THE ENVIRONMENT OPERATION ACT (POEO 1997) AND SHALL BE APPROVED BY LOCAL COUNCIL

ADOPT TEMPORARY MEASURES AS MAY BE NECESSARY FOR EROSION & SEDIMENT CONTROL, INCLUDING BUT NOT LIMITED TO

EROSION & SEDIMENT CONTROL, INCLUDING BUT NOT LIMITED TO THE FOLLOWING: – DRAINS: TEMPORARY DRAINS AND CATCH DRAINS. – SPREADER BANKS OR OTHER STRUCTURES: TO DISPERSE CONCENTRATED RUNOFF. – SILT TRAPS: CONSTRUCTION AND MAINTENANCE OF SILT TRAPS TO PREVENT DISCHARGE OF SCOURED MATERIAL TO DOWNSTREAM APEAS

AFTER RAIN, INSPECT, CLEAN, AND REPAIR IF REQUIRED, TEMPORARY EROSION & SEDIMENT CONTROL MEASURES.

REMOVE TEMPORARY EROSION & SEDIMENT CONTROL MEASURES WHEN THEY ARE NO LONGER REQUIRED.

COMPLY WITH THE REQUIREMENTS OF LANDCOM'S MANAGING STORMWATER - SOIL AND CONSTRUCTION 'THE BLUE BOOK' LATEST EDITION

THE EROSION & SEDIMENT CONTROL PLAN PROVIDED IS ONLY INDICATIVE. THE CONTRACTOR SHOULD PREPARE A DETAILED ESCP SUITABLE FOR THE SPECIFIC SITE CONDITIONS



DIAL BEFORE YOU DIG SHOULD BE CONTACTED PRIOR TO ANY EXCAVATION ON SITE TM: TRADE MARK OF THE ASSOCIATION OF DIAL BEFORE YOU DIG SERVICES LTD. USED UNDER LICENSE.

#### GENERAL NOTES

ALL WORK SHALL BE CARRIED OUT IN ACCORDANCE WITH COUNCIL'S REQUIREMENTS, BUILDING CODE OF AUSTRALIA, NSW CODE OF PRACTICE AND THE TO THE RELEVANT SERVICE CODES.

THESE DRAWINGS SHALL BE READ IN CONJUNCTION WITH ALL ARCHITECTURAL AND OTHER CONSULTANTS' DRAWINGS AND SPECIFICATIONS AND WITH SUCH OTHER WRITTEN INSTRUCTIONS AS MAY BE ISSUED DURING THE COURSE OF THE CONTRACT. ALL DISCREPANCIES SHALL BE REFERRED TO THE SUPERINTENDENT FOR DECISION BEFORE PROCEEDING WITH THE WORK.

ALL DIMENSIONS SHOWN ON THE DRAWINGS ARE IN MILLIMETERS (U.N.O.), DIMENSIONS SHALL NOT BE OBTAINED BY SCALING OF THESE DRAWINGS. USE FIGURED DIMENSIONS ONLY.

BENCHMARKS HAVE BEEN ESTABLISHED WHERE INDICATED ON THE DRAWINGS, ALL LEVELS ARE TO AUSTRALIAN HEIGHT DATUM (A.H.D.). THE CONTRACTOR SHALL UNDERTAKE ALL NECESSARY SURVEY WORK TO ENSURE THAT THE WORKS ARE CONSTRUCTED TO DESIGN LINE AND LEVEL

SETTING OUT DIMENSIONS AND LEVELS SHOWN ON THE DRAWINGS SHALL BE VERIFIED BY THE CONTRACTOR.

. MATERIALS SHALL BE IN ACCORDANCE WITH THE REQUIREMENTS THE RELEVANT SAA CODES AND THE BY-LAWS AND ORDINANCES THE RELEVANT BUILDING AUTHORITIES.

IT IS THE CONTRACTOR'S RESPONSIBILITY TO PROVIDE ALL SAFETY FENCES, WARNING SIGNS, TRAFFIC DIVERSIONS AND THE LIKE DURING CONSTRUCTION. ALL WORKS TO COMPLY WITH WORK HEALTH AND SAFETY REQUIREMENTS AND OTHER RELEVANT AUTHORITY SAFETY REQUIREMENTS

NO TREES SHALL BE REMOVED, CUTBACK OR RELOCATED WITHOUT THE WRITTEN INSTRUCTION FROM THE SUPERINTENDENT.

WHERE NEW WORKS ABUT EXISTING THE CONTRACTOR SHALL ENSURE THAT A SMOOTH EVEN PROFILE, FREE FROM ABRUPT CHANGES IS THAT A SOBTAINED.

ALL WORKS SHALL BE CARRIED OUT IN ACCORDANCE WITH THE DETAILS SHOWN ON THE DRAWINGS AND THESE SPECIFICATIONS.

DESIGN LEVELS GIVEN ARE TO FINISHED SURFACE LEVEL AND INCLUSIVE OF TOPSOIL. (TOPSOIL DEPTH VARIES)

CONTRACTOR SHALL ARRANGE ALL SURVEY SETOLIT TO BE CARRIED OUT BY A N.A.T.A. REGISTERED SURVEYOR

CARE IS TO BE TAKEN WHEN EXCAVATING NEAR EXISTING SERVICES. NO MECHANICAL EXCAVATIONS ARE TO BE UNDERTAKEN OVER TELECOMMUNICATIONS OR ELECTRICAL SERVICES. HAND EXCAVATE IN THEFE ADE THESE AREAS

THE LOCATIONS OF UNDERGROUND SERVICES SHOWN ON THE DRAWING HAVE BEEN PLOTTED FROM DIAGRAMS PROVIDED BY SERVICE AUTHORITIES. THIS INFORMATION HAS BEEN PREPARED SOLELY FOR THE AUTHORITIES OWN USE AND MAY NOT NECESSARILY BE UPDATED OR ACCURATE.

THE POSITION OF SERVICES AS RECORDED BY THE AUTHORITY AT THE TIME OF INSTALLATION MAY NOT REFLECT CHANGES IN THE PHYSICAL ENVIRONMENT SUBSEQUENT TO INSTALLATION.

MODULAR ENGINEERS DOES NOT GUARANTEE THAT THE SERVICES INFORMATION SHOWN ON THE DRAWING SHOWS MORE THAN THE PRESENCE OR ABSENCE OF SERVICES, AND WILL ACCEPT NO LIABILITY FOR INACCURACIES IN THE SERVICES INFORMATION SHOWN FROM ANY CAUSE WHATSOEVER

IT IS THE CONTRACTOR'S RESPONSIBILITY TO OBTAIN FROM THE UTILITY SERVICES AUTHORITIES A CURRENT COPY OF UNDERGROUND SERVICES SEARCH FOR THE LOCATION OF ALL EXISTING SERVICES PRIOR TO COMMENCEMENT OF ANY WORK AND NOTIFY ANY CONFLICT WITH THE DRAWINGS IMMEDIATELY, CLEARANCE SHALL BE OBTAINED FROM THE RELEVANT REGULATORY AUTHORITY. CONTRACTOR TO KEEP COPY OF UNDERGROUND SERVICES SEARCH ON SITE AT ALL TIMES. ANY DAMAGES TO SERVICES OR SERVICES ADJUSTMENTS SHALL BE CARRIED OUT BY THE CONTRACTOR OR RELEVANT AUTHORITY. AT THE CARRIED OUT BY THE CONTRACTOR OR RELEVANT AUTHORITY AT THE CONTRACTOR'S EXPENSE.

VISIT THE SITE BEFORE SUBMITTING THE FINAL TENDER PRICE TO ASSESS 'ON SITE' CONDITIONS. FAILURE TO DO SO WILL FORFEIT ANY CLAIM FOR NOT BEING AWARE OF CONDITIONS AFFECTING THE TENDER.

THE CONTRACTOR SHALL PREPARE ACCURATE WORK-AS-EXECUTED DRAWINGS FOLLOWING THE COMPLETION OF ALL WORKS.

IT IS THE CONTRACTOR'S RESPONSIBILITY TO HAVE IN PLACE & MAINTAIN TRAFFIC FACILITIES AT ALL TIMES DURING CONSTRUCTION.

## LEGEND

55	
DP	DOWNPIPE
	STORMWATER GRAVITY LINE
	STORMWATER CHARGED LINE
<u> </u>	SUBSOIL LINE
SW SW	EXISTING STORMWATER LINE
s s	AUTHORITY SEWER LINE
	SEDIMENT FENCE
	GRATED SURFACE INLET PIT
	GRATED TRENCH DRAIN
CEO	CLEANING EYE
x <sup>R.L. 51.83</sup>	PROPOSED SPOT LEVEL
	EXISTING GRATED SURFACE INLET PIT
$\boxtimes$	EXISTING JUNCTION PIT
	EXISTING KERB INLET PIT
eTEL	EXISTING TELSTRA PIT
王 eHYD	EXISTING HYDRANT
► eSV	EXISTING STOP VALVE
🖸 eGAS	EXISTING GAS VALVE
O ePP	EXISTING POWER POLE
esmh	EXISTING SEWER MANHOLE
	OVERLAND FLOW PATH

#### **ABBREVIATIONS:**


Ø or DIA CBR CH


CL CO DD DDO DP


FFL GTD GSIP HYD


⊩ KIP K&G K&G LS NGL

10	OFP OSD R RCP	OVERLAND FLOW PATH ON-SITE DETENTION RADIUS REINFORCED CONCRETE PIPE
	RL RW RWT	REDUCED LEVEL RETAINING WALL RAINWATER TANK
	SJ SMH	SAWN CONTROL JOINT SEWER MAN HOLE
	SW SWP	STORMWATER STORMWATER PIT
PIT	SWRM SV TOK TOW TWL TP UPVC	STORMWATER RISING MAIN STOP VALVE TOP OF KERB TOP OF WALL TOP WATER LEVEL TANGENT POINT UNPLASTICISED POLYVINYL
	CHLORIDE UNO FF TYP	UNLESS NOTED OTHERWISE FIRST FLUSH DEVICE TYPICAL

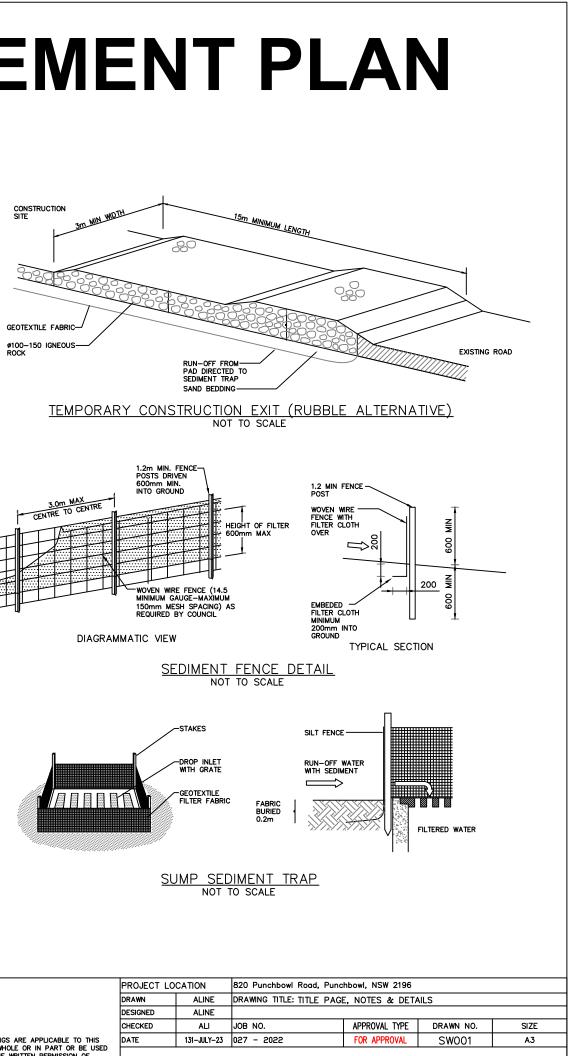

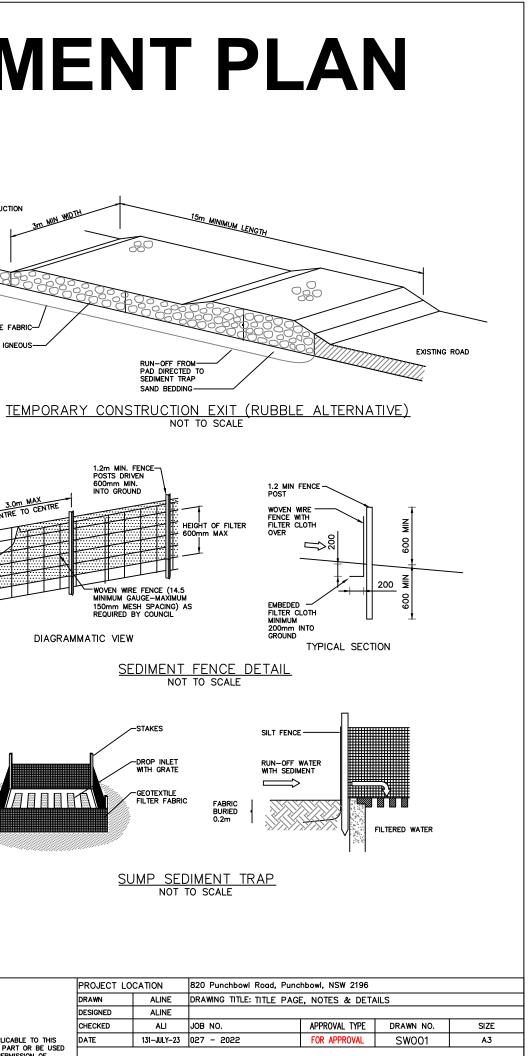


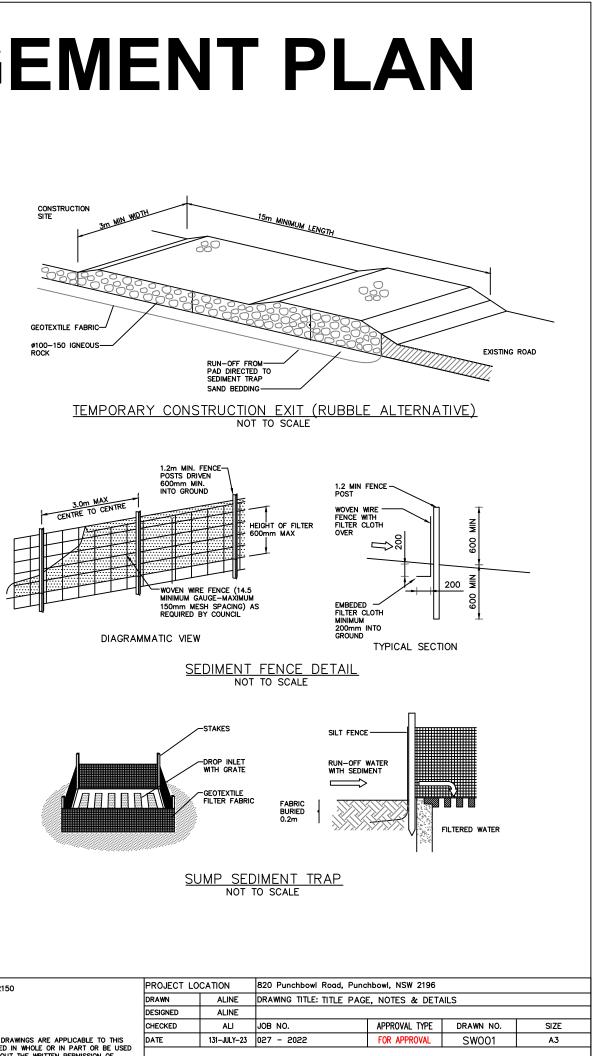

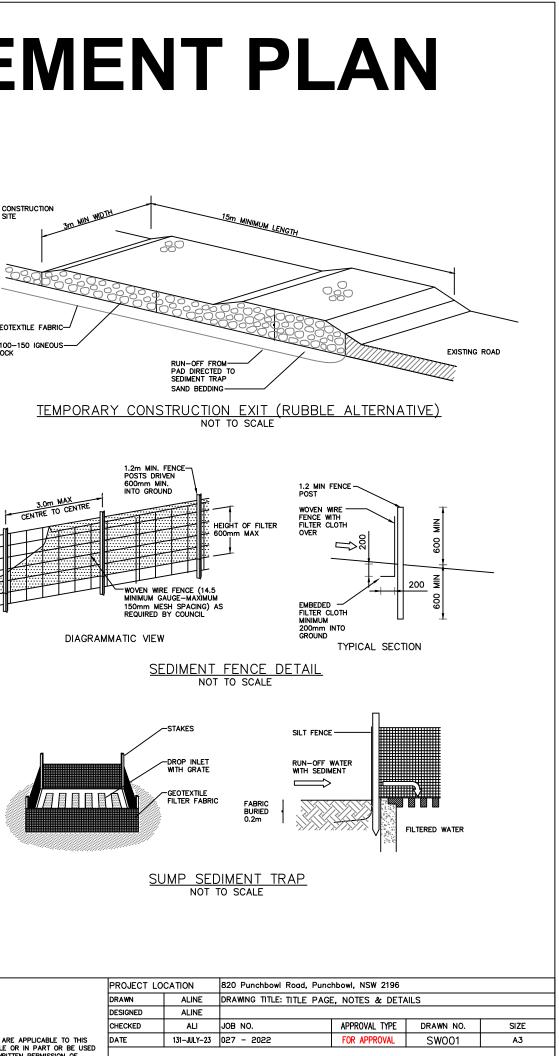


		REVISIONS			A 6/7 Parkes Street,Parramatta NSW 2150	PROJECT LO	OCATION
REV.	DATE	DESCRIPTION	ENG.	DFT.		DRAWN	ALINE
A	26/02/2022	ISSUED FOR DA	A.S.	A.S.		DESIGNED	ALINE
В	22/06/2023	ISSUED FOR DA	S.R.	S.R.		CHECKED	ALI
					THE DESIGN AND DETAILS SHOWN ON THESE DRAWINGS ARE APPLICABLE TO THIS	DATE	131-JULY-23
					ENGINEERS PITLID PROJECT ONLY AND MAY NOT BE REPRODUCED IN WHOLE OR IN PART OR BE USED FOR ANY OTHER PROJECT OR PURPOSE WITHOUT THE WRITTEN PERMISSION OF		
					STRUCTURAL, CIVIL, & HYDRAULIC CONSULTANT MODULAR ENGINEERS WITH WHOM COPYRIGHT RESIDES		

DIAMETER CALIFORNIA BEARING RATIO CHAINAGE CENTER LINE CLEAR OUT DISH DRAIN OUTLET DISH DRAIN OUTLET DOWNPIPE EXISTING FINISHED FLOOR LEVEL GRATED TRENCH DRAIN GRATED SURFACE INLET F HYDRÄNT ISOLATING JOINT INVERT LEVEL INTERSECTION POINT KERB INLET PIT KERB & GUTET KERB & GUTET KERB & GUTET LONGITUDINAL SECTON NATURAL GROUND LEVEL HYDRANT

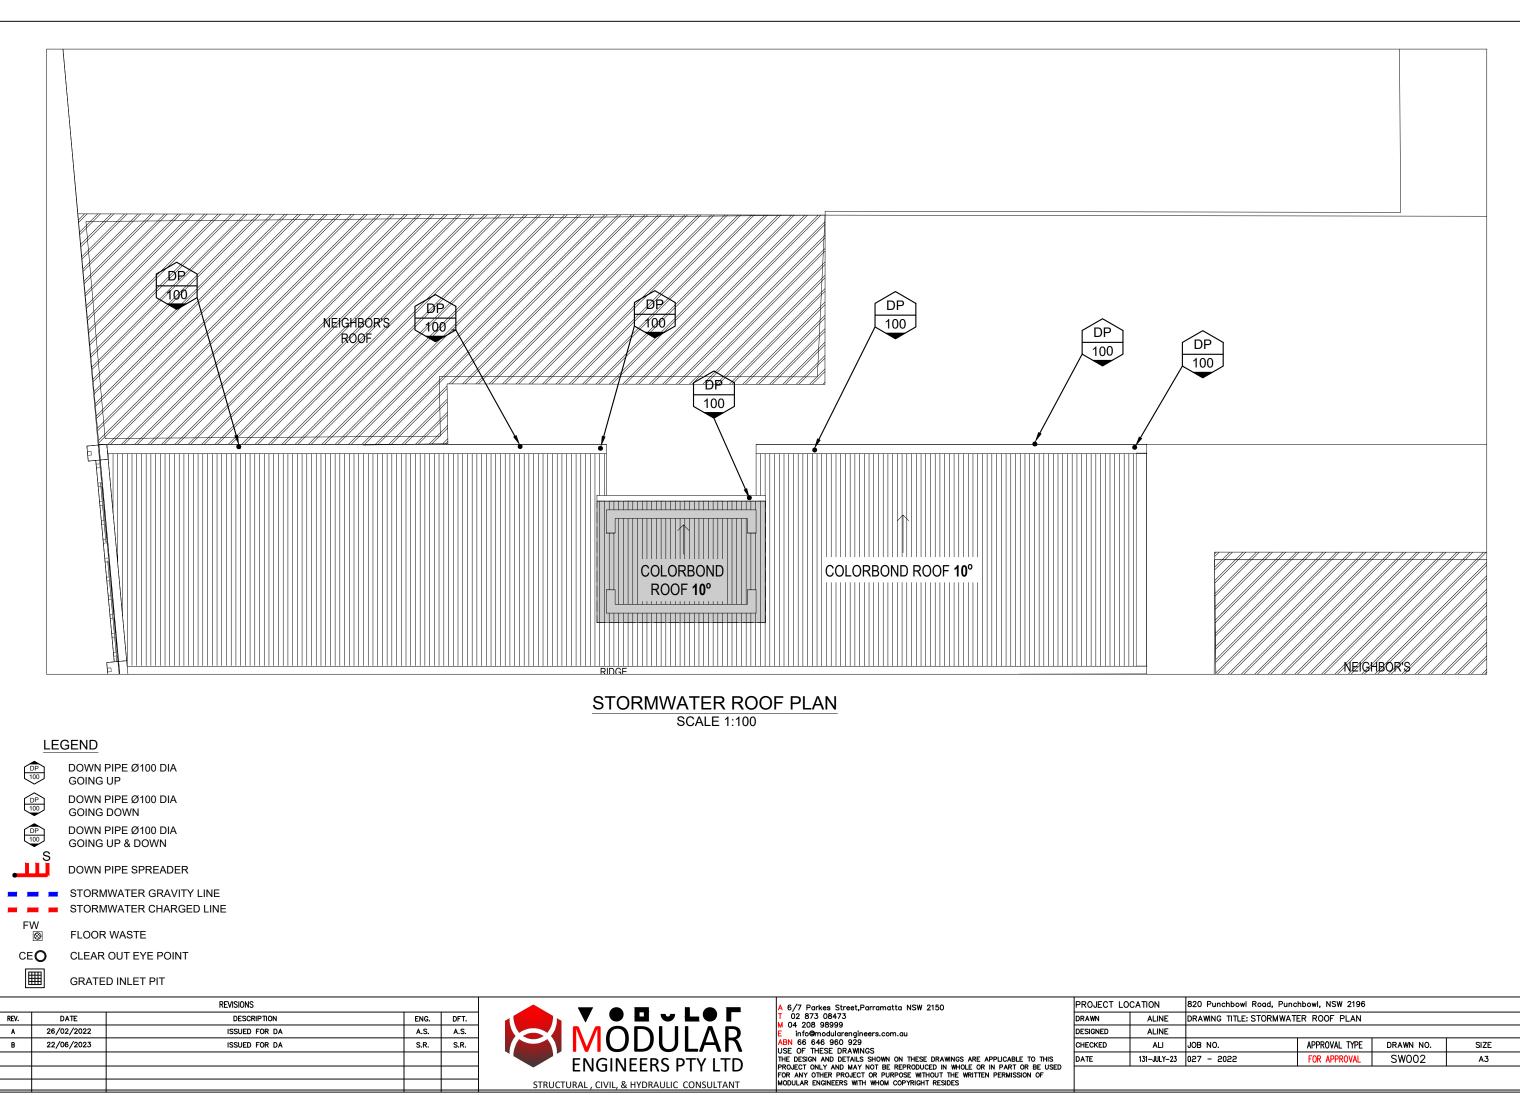


STRUCTURAL, CIVIL, & HYDRAULIC CONSULTANT

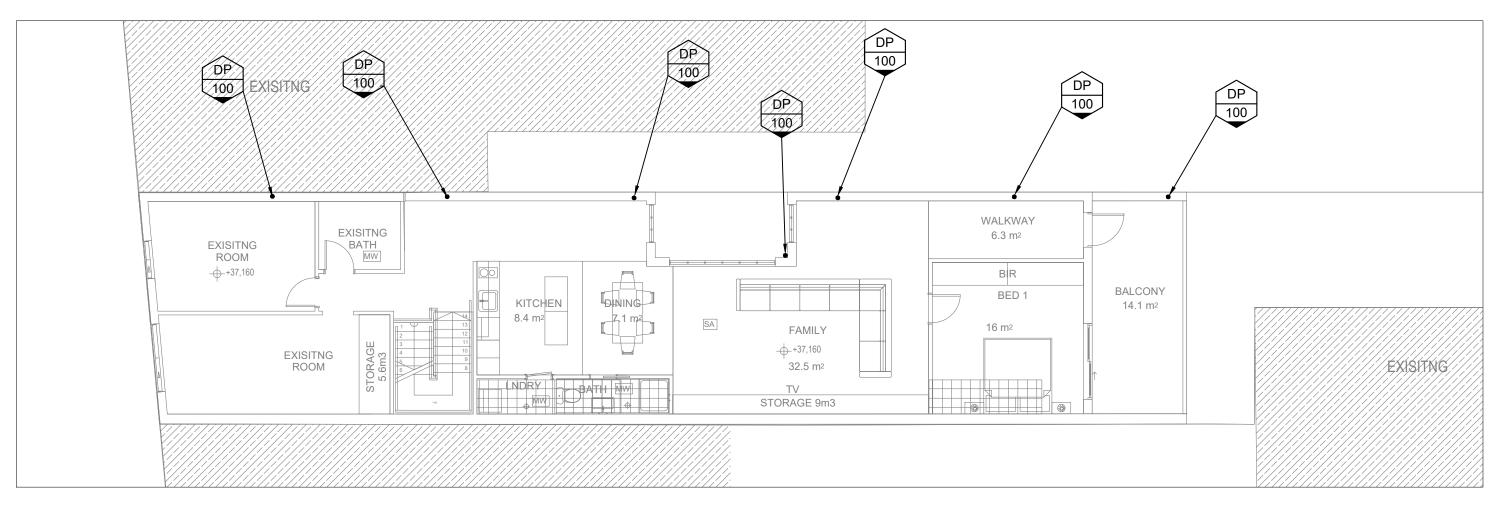

## STORMWATER FIRST FLOOR PLAN

SCALE 1:100

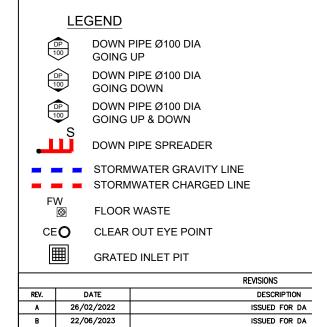


	<b>NODULAR</b> ENGINEERS PTY LTD
STRUCT	URAL , CIVIL, & HYDRAULIC CONSULTANT


ENG. DFT.

A.S. A.S.


S.R. S.R.

A 6/7 Parkes Street,Parramatta NSW 2150	PROJECT LOO	CATION	820 Punchbowl Road, Punchbowl, NSW 2196				
T 02 873 08473 M 04 208 98999	DRAWN	ALINE	DRAWING TITLE: STORMWATER FIRST FLOOR PLAN				
	DESIGNED	ALINE					
ABN 66 646 960 929 USE OF THESE DRAWINGS	CHECKED	ALI	JOB NO.	APPROVAL TYPE	DRAWN NO.	SIZE	
THE DESIGN AND DETAILS SHOWN ON THESE DRAWINGS ARE APPLICABLE TO THIS	DATE	131-JULY-23	027 - 2022	FOR APPROVAL	SW003	A3	
OJECT ONLY AND MAY NOT BE REPRODUCED IN WHOLE OR IN PART OR BE USED R ANY OTHER PROJECT OR PURPOSE WITHOUT THE WRITTEN PERMISSION OF DULAR ENGINEERS WITH WHOM COPYRIGHT RESIDES							

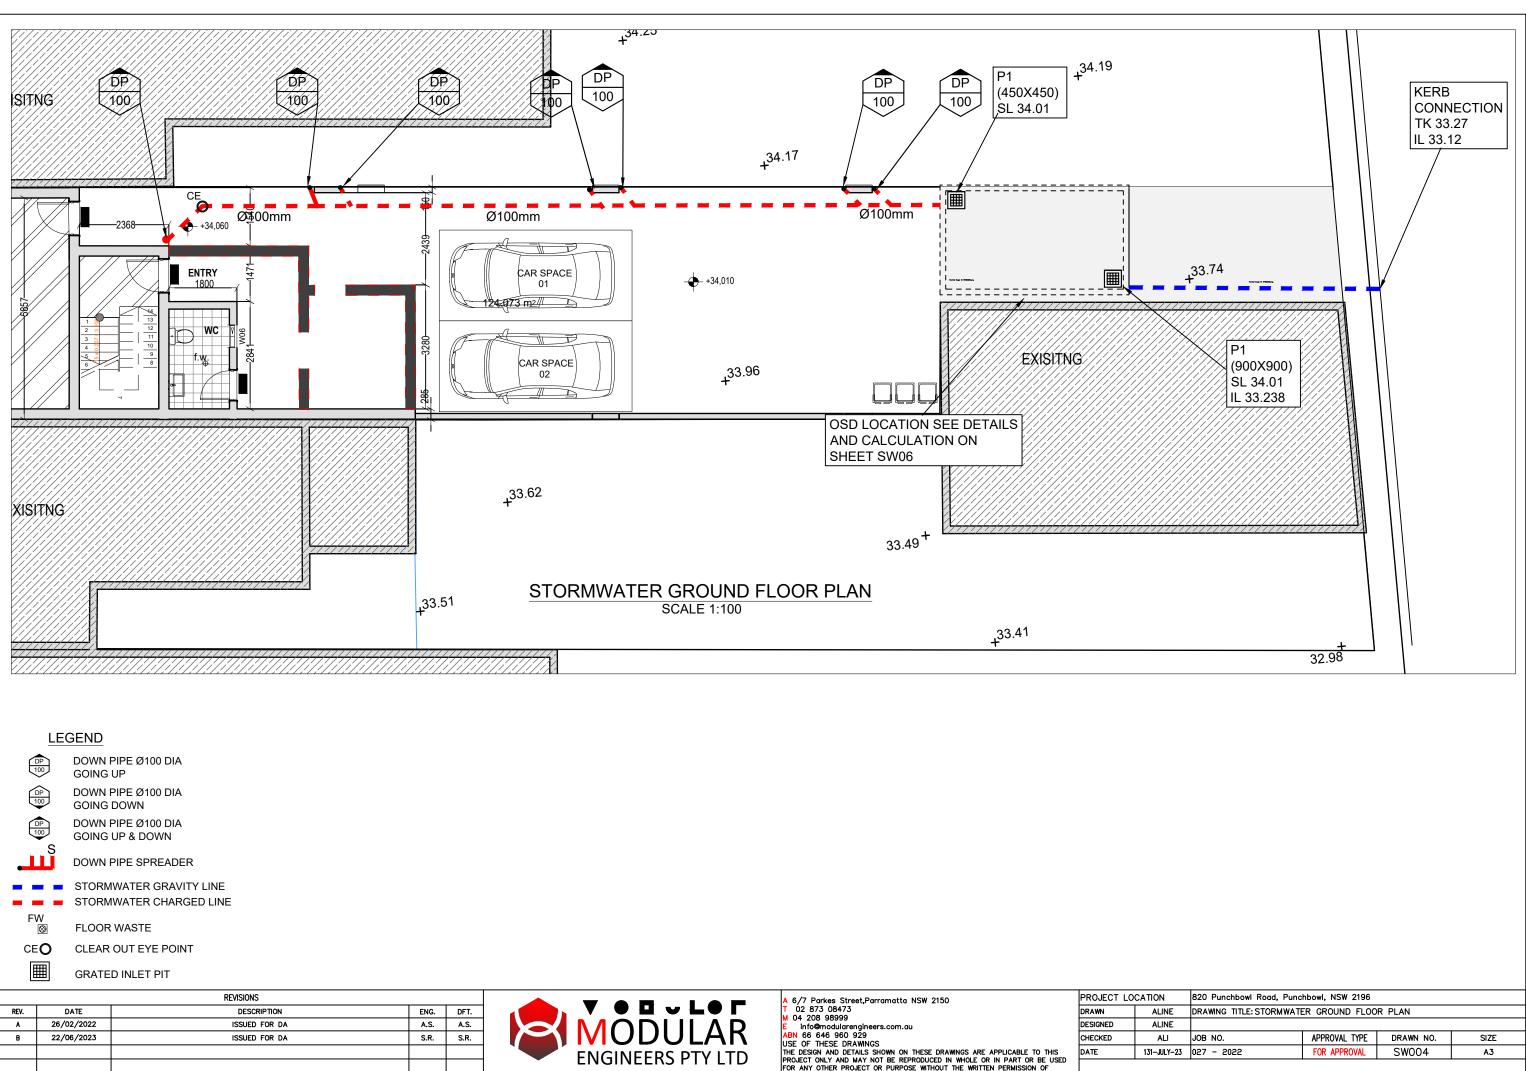

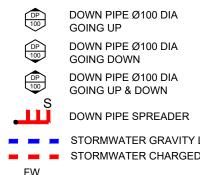

		REVISIONS			A 6/7 Parkes Street,Parramatta NSW 2150	PROJECT LO	CATION
REV.	DATE	DESCRIPTION	ENG.	DFT.		DRAWN	ALINE
A	26/02/2022	ISSUED FOR DA	A.S.	A.S.		DESIGNED	ALINE
B	22/06/2023	ISSUED FOR DA	S.R.	S.R.		CHECKED	ALI
					THE DESIGN AND DETAILS SHOWN ON THESE DRAWINGS ARE APPLICABLE TO THIS	DATE	131-JULY-2
					EINGINEERS PIY LID PROJECT ONLY AND MAY NOT BE REPRODUCED IN WHOLE OR IN PART OR BE USED FOR ANY OTHER PROJECT OR PURPOSE WITHOUT THE WRITTEN PERMISSION OF		
					STRUCTURAL, CIVIL, & HYDRAULIC CONSULTANT MODULAR ENGINEERS WITH WHOM COPYRIGHT RESIDES	ļ	

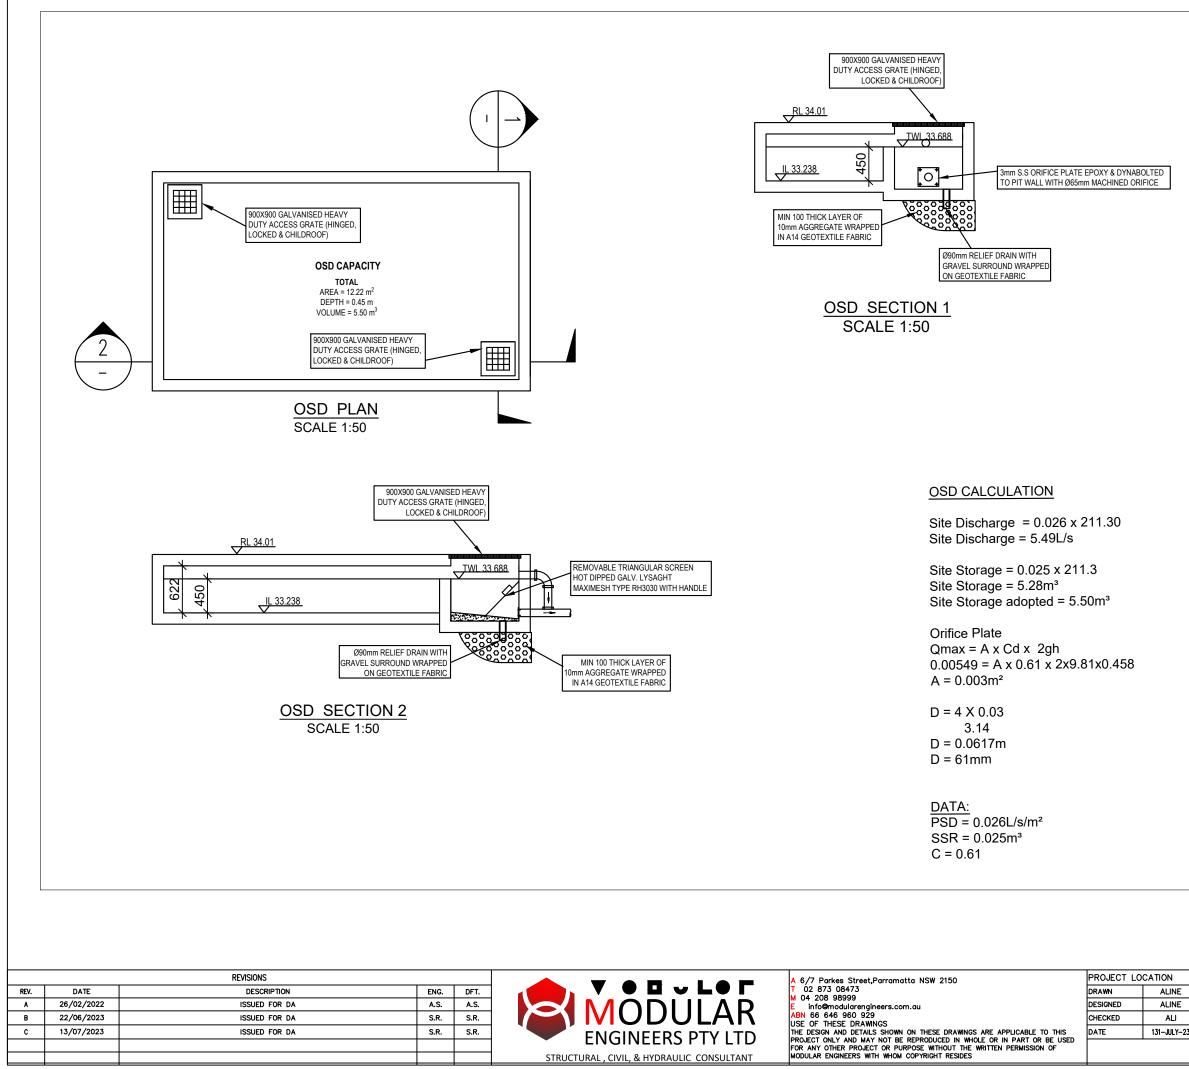


A.S.	
S.R.	
S.R.	ENGINEERS PTY LTD
	STRUCTURAL , CIVIL, & HYDRAULIC CONSULTANT


		CO	DANGER NFINED SPACE DENTRY WITHOUT DONFINED SPACE TRAINING VOTH 2455	HERIT Stan
	ł		ORIFICE DIA 65mm 3mm stainless Steel plate #100 upvc outlet	
	820 Punchbowl Road, Punc	hbowl, NSW 2196		
	DRAWING TITLE: OSD DETAI		TION	
-	JOB NO.	APPROVAL TYPE	DRAWN NO.	SIZE
-23	027 - 2022	FOR APPROVAL	SW005	A3


		REVISIONS		
REV.	DATE	DESCRIPTION	ENG.	DFT.
A	26/02/2022	ISSUED FOR DA	A.S.	A.S.
B	22/06/2023	ISSUED FOR DA	S.R.	S.R.
С	13/07/2023	ISSUED FOR DA	S.R.	S.R.
	i i			



	T 02 873 08473 M 04 208 98999	PROJECT LO	CATION	820 Punchbowl Road, Punchbowl, NSW 2196				
		DRAWN	ALINE	DRAWING TITLE: DETALS AND NOTES				
		DESIGNED	ALINE					
	ABN 66 646 960 929 USE OF THESE DRAWINGS	CHECKED	ALI	JOB NO.	APPROVAL TYPE	DRAWN NO.	SIZE	
	THE DESIGN AND DETAILS SHOWN ON THESE DRAWINGS ARE APPLICABLE TO THIS	DATE	131-JULY-23	027 - 2022	FOR APPROVAL	SW006	A3	
	PROJECT ONLY AND MAY NOT BE REPRODUCED IN WHOLE OR IN PART OR BE USED FOR ANY OTHER PROJECT OR PURPOSE WITHOUT THE WRITTEN PERMISSION OF MODULAR ENGINEERS WITH WHOM COPYRIGHT RESIDES					•		

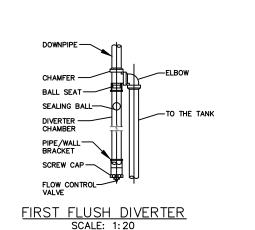

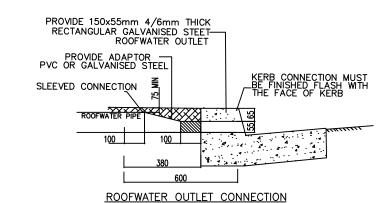

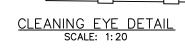



CAP TO BE SECURED-WITH CONCRETE SURROUND

LIGHT DUTY AIR TIGHT SCREW DOWN CAP

uPVC PIPE DRAINAGE -LINE AT MIN 1.0% GRADE

FLOW

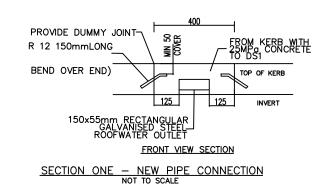

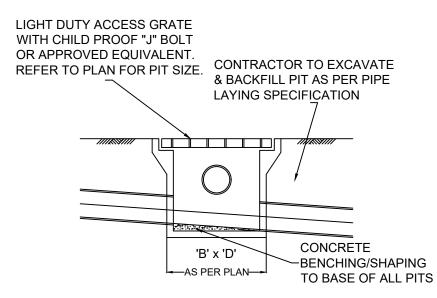

ALL PITS GREATER THAN 900mm DEEP SHALL BE PROVIDED WITH A CHILD-PROOF LOCKING CLIP ALL PITS SHALL BE MAINTAINED REGULARLY ALL PITS TO BE BENCHED MIN. 20mm TO INVERT OF OUTLET

Ø100 SUBSOIL DRAINAGE PIPE WRAPPED IN FABRIC SOCK TO BE PROVIDED IN ALL LANDSCAPED AREAS & BEHIND RETAINING WALLS AND CONNECTED TO THE NEAREST STORMWATER PIT.

COMPRESSIVE STRENGTH  $f^*_{\mbox{\scriptsize e}}$  for Cast in situ concrete to be a minimum of 20MPa at 28 days

PROVIDE CLEANING EYES TO ALL DOWNPIPES NOT DIRECTLY CONNECTED TO PITS

ISOLATED JOINTS TO BE PROVIDED TO ISOLATE CONCRETE PAVEMENTS FROM PITS

ALL TRENCH GRATES PROVIDED SHALL HAVE A MINIMUM CLEAR WIDTH OF 200mm

STORMWATER DRAINAGE CONNECTIONS TO THE MAIN SYSTEM SHALL BE TO THE REQUIREMENTS AND THE SATISFACTION OF LOCAL COUNCIL

### UPPER LEVEL NOTES:

DRAINAGE NOTES:

ALL PIPES TO BE LAID ON 75mm SAND BED WITH THE BARRELS FULLY SUPPORTED 100mm AND 150mm DIAMETER PIPES TO BE LAID ON MINIMUM 1% GRADE MINIMUM DEPTH OF COVER FOR PIPES NOT SUBJECT TO VEHICULAR LOADING TO BE 300mm ALL DRAINAGE PIPES LAID UNDER PAVEMENT SHALL BE REINFORCED CONCRETE WITH RUBBER RING JOINTS BACKFILL TRENCHES WITH COMPACTED SAND OR APPROVED AGGREGATE MATERIAL

ALL PITS TO HAVE 600x600mm INTERNAL DIMENSIONS (U.N.O.)

SILT ARRESTORS TO HAVE 900x900mm INTERNAL DIMENSIONS

HEAVY DUTY GALV. STEEL GRATES AND COVERS ARE TO BE PROVIDED IN TRAFFICABLE AREAS

PIT GRATE TO BE TYPE WELDLOK OR APPROVED EQUIVALENT

HEEL & WHEELCHAIR SAFE GRATE COVERS ARE TO BE PROVIDED IN PEDESTRIAN AREAS

INSTALL #65mm uPVC SPITTER PIPES 20mm ABOVE SURFACE LEVEL FOR BALCONY AND CONCRETE ROOF AREAS TO ALLOW FOR EMERGENCY OVERFLOW INCASE OF BLOCKAGES DURING HEAVY STORMS. PLUMBER TO CONFIRM LOCATION DURING CONSTRUCTION.

BALCONY, TERRACE & CONCRETE ROOF AREAS TO BE FITTED WITH RAINWATER OUTLETS AND CONNECTED TO NEAREST DOWNPIPE WHERE REQUIRED (TYP).

DOWNPIPES (DP) SHOWN ON PLAN ARE TO BE <code>#100mm uPVC</code> OR 100x75 U.N.O. (TYP).

CHARGED DOWNPIPES SHOWN ON PLAN MUST BE SEWER GRADE #100mm uPVC WITH ALL JOINTS SOLVENT WELDED TO A LEVEL 1200mm ABOVE THE RAINWATER TANK INLET R.L. (TYP).


PROPOSED DOWNPIPE LOCATIONS ARE NOMINAL AND TO BE CONFIRMED DURING CONSTRUCTION (TYP).

INSTALL DOWNPIPE WITH SPREADER PIPE (SP) (IF REQUIRED) TO DISPERSE STORMWATER ONTO LOWER ROOF AREAS EFFECTIVELY.

# **TYPICAL SURFACE INLET PIT**

**DETAIL** N.T.S

TYPICAL FOR ALL PITS IN NON TRAFFIC AREAS.

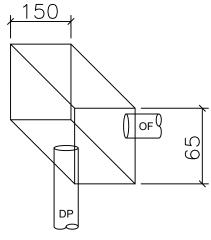

BOX GUTTER TYPICAL	DETAIL